APPLICATION FOR PLANNING APPROVAL

Application Number: DA-2025-309

Proposal: Extension to dwelling

Subject Site: 134 Wiggins Road, Longley

Responsible Planning Officer: Ho Ho Lam

Advertised Documents:

Application Plans

• Natural Values Assessment

Bushfire Hazard Report

Available upon request:


Application Form

Copy of Title

NOTE: The documents included for advertising (public notice) have been provided by the applicant. The advertising of the documentation does not confirm that Council agrees with, or endorses, the content or assessments.

Representations:

Representations must be provided in writing to Council stating the reasons why you support or object to the application. Representations for this application must be submitted by 11.59pm on **5 December 2025**; and can be delivered in person to the Civic Centre, posted to Locked Bag 1, Kingston 7050 or emailed to kc@kingborough.tas.gov.au.

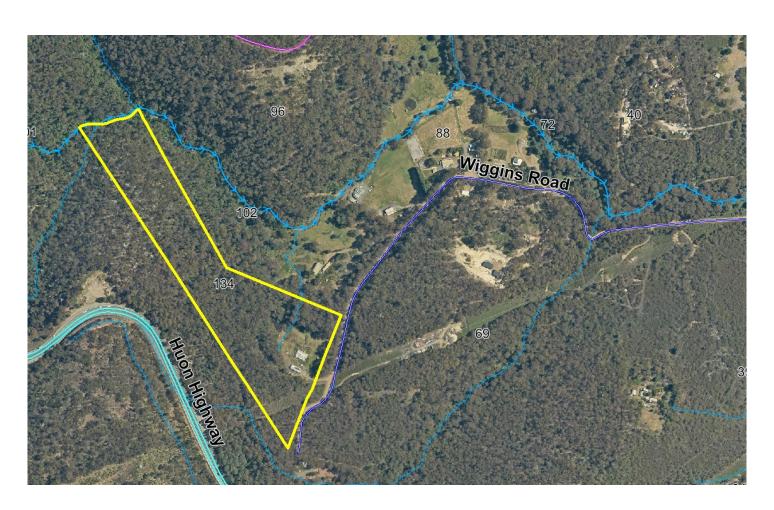

PINNACLE

Kingborough Council

Development Application: DA-2025-309
Plan Reference No: P4
Date Received: 18/11/2025
Date placed on Public Exhibition: 22/11/2025

PINNACLE







Note: The images provided are artistic representations only and should not be used as references for final colours, finishes, or external/internal features.

134 Wiggins Road, Longley 7150

Owner(s) or Clients

Building Classification

Designer

Total Floor Area (Combined)

Alpine Area

Other Hazards

(e.g.. High wind, earthquake, flooding, landslip, dispersive soils, sand dunes, mine subsidence, landfill, snow & ice, or other relevant factors)

Dean Meacham & Megan Burkett

1a

Jason Nickerson CC6073Y 238.97m² Deck 18.00m²

N/A

Scenic Landscape Area, Biodiversity Protection Area, Waterway and Coastal Protection Area, Electricity Transmission Infrastructure Protection, Landslide Hazard Area, Bushfire Prone Areas Title Reference 53103/1

Zoning Rural Resource

Land Size 75,727m²

Design Wind Speed TBA

Soil Classification TBA

Climate Zone 7

Corrosion Environment Low

Bushfire Attack Level (BAL) 29


Changes List				
Issue	Description of change	Date	Designer	
Ch - 01	HMA Visual Reference - Amended	7/11/25	SH	
Ch - 02	Cut Depths	1/10/25	SH	
Ch - 03	Tree Plan & Accompanying Table of Trees	7/11/25	SH	

Kingborough Council

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ID	Sheet Name	Issue
A.01	Location Plan - A2	DA - 01
A.02	Site Plan - Existing - A2	DA - 01
A.03	Site Plan - Proposed - A2	DA - 01
A.04	Floor Plan - Demolition - A2	DA - 01
A.05	Floor Plan - Proposed - A2	DA - 01
A.06	Elevations - Existing	DA - 01
A.07	Elevations - Existing / Demolition	DA - 01
A.08	Elevations - Proposed	DA - 01
A.09	Elevations - Proposed	DA - 01
A.10	Roof Plan	DA - 01
A.11	Electrical Plan - Reflected Ceiling	DA - 01
A.12	Electrical Plan - Power	DA - 01



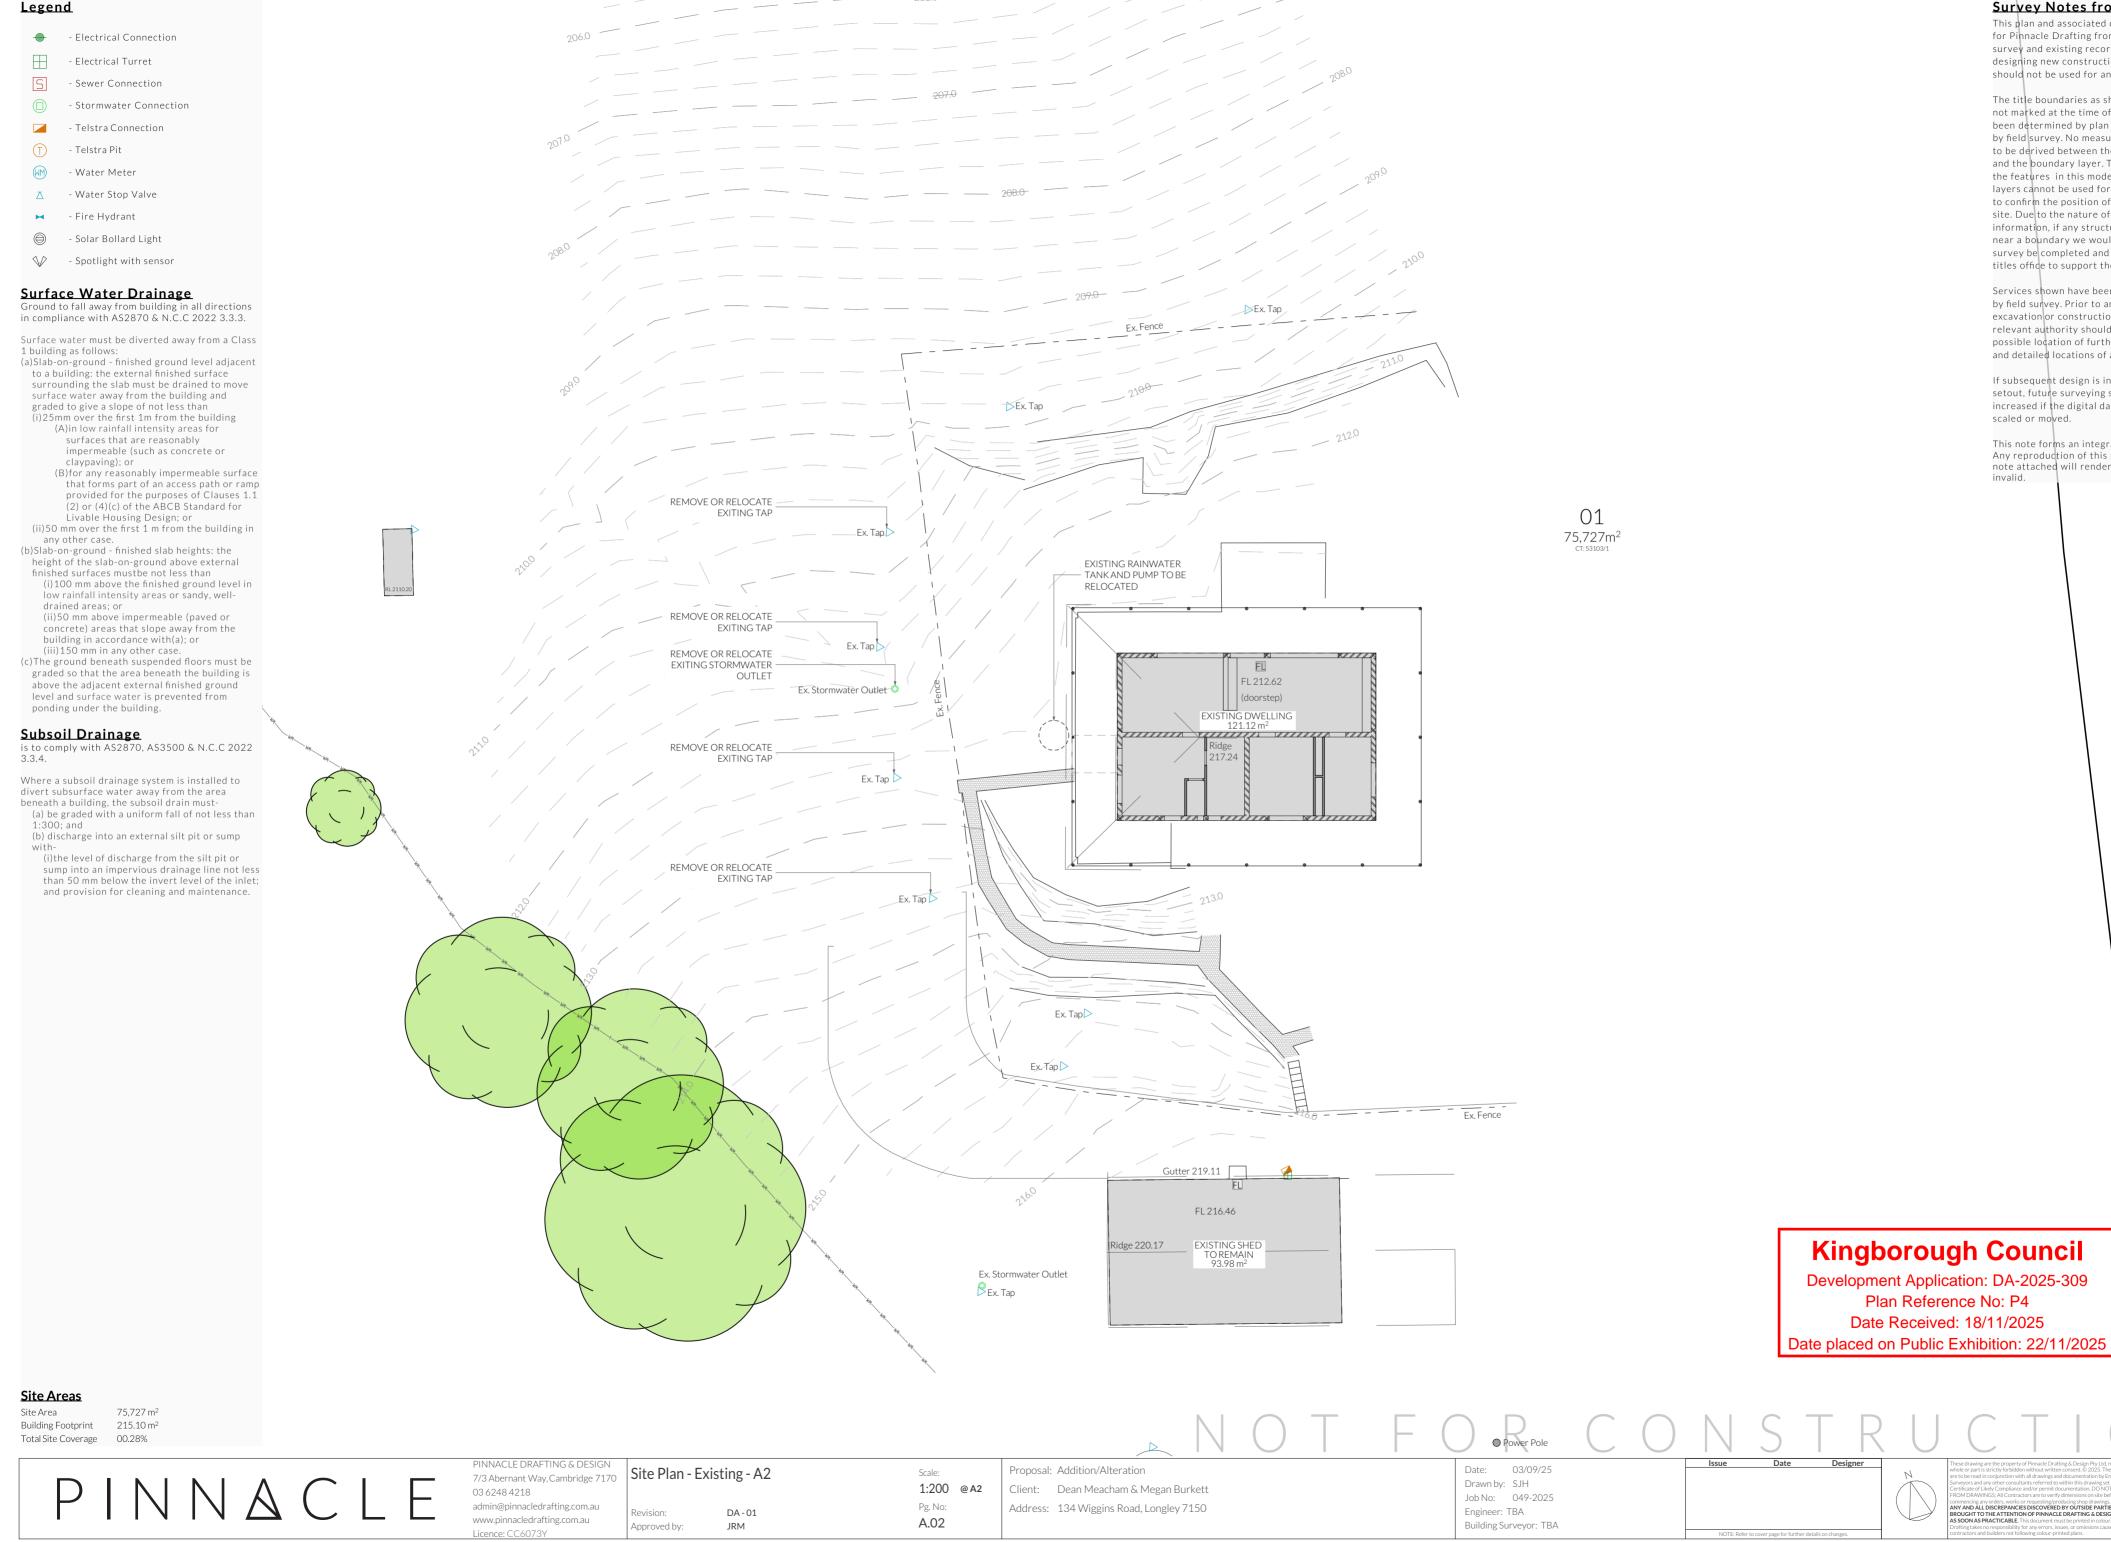

Survey Notes from Surveyor

This plan and associated digital model is prepared for Pinnacle Drafting from a combination of field survey and existing records for the purpose of designing new constructions on the land and should not be used for any other purpose.

The title boundaries as shown on this plan were not marked at the time of the survey and have been determined by plan dimensions only and not by field survey. No measurements or offsets are to be derived between the features on this plan and the boundary layer. The relationship between the features in this model and the boundary layers cannot be used for any set out purposes or to confirm the position of the title boundaries on site. Due to the nature of the title boundary information, if any structures are designed on or near a boundary we would recommend a re-mark survey be completed and lodged with the land titles office to support the boundary definition.


Services shown have been located where visible by field survey. Prior to any demolition, excavation or construction on the site, the relevant authority should be contacted for possible location of further underground services and detailed locations of all services.

If subsequent design is intended for construction setout, future surveying setout costs are increased if the digital data provided is rotated,

This note forms an integral part of the plan/data. Any reproduction of this plan/model without this note attached will render the information shown

Development Application: DA-2025-309



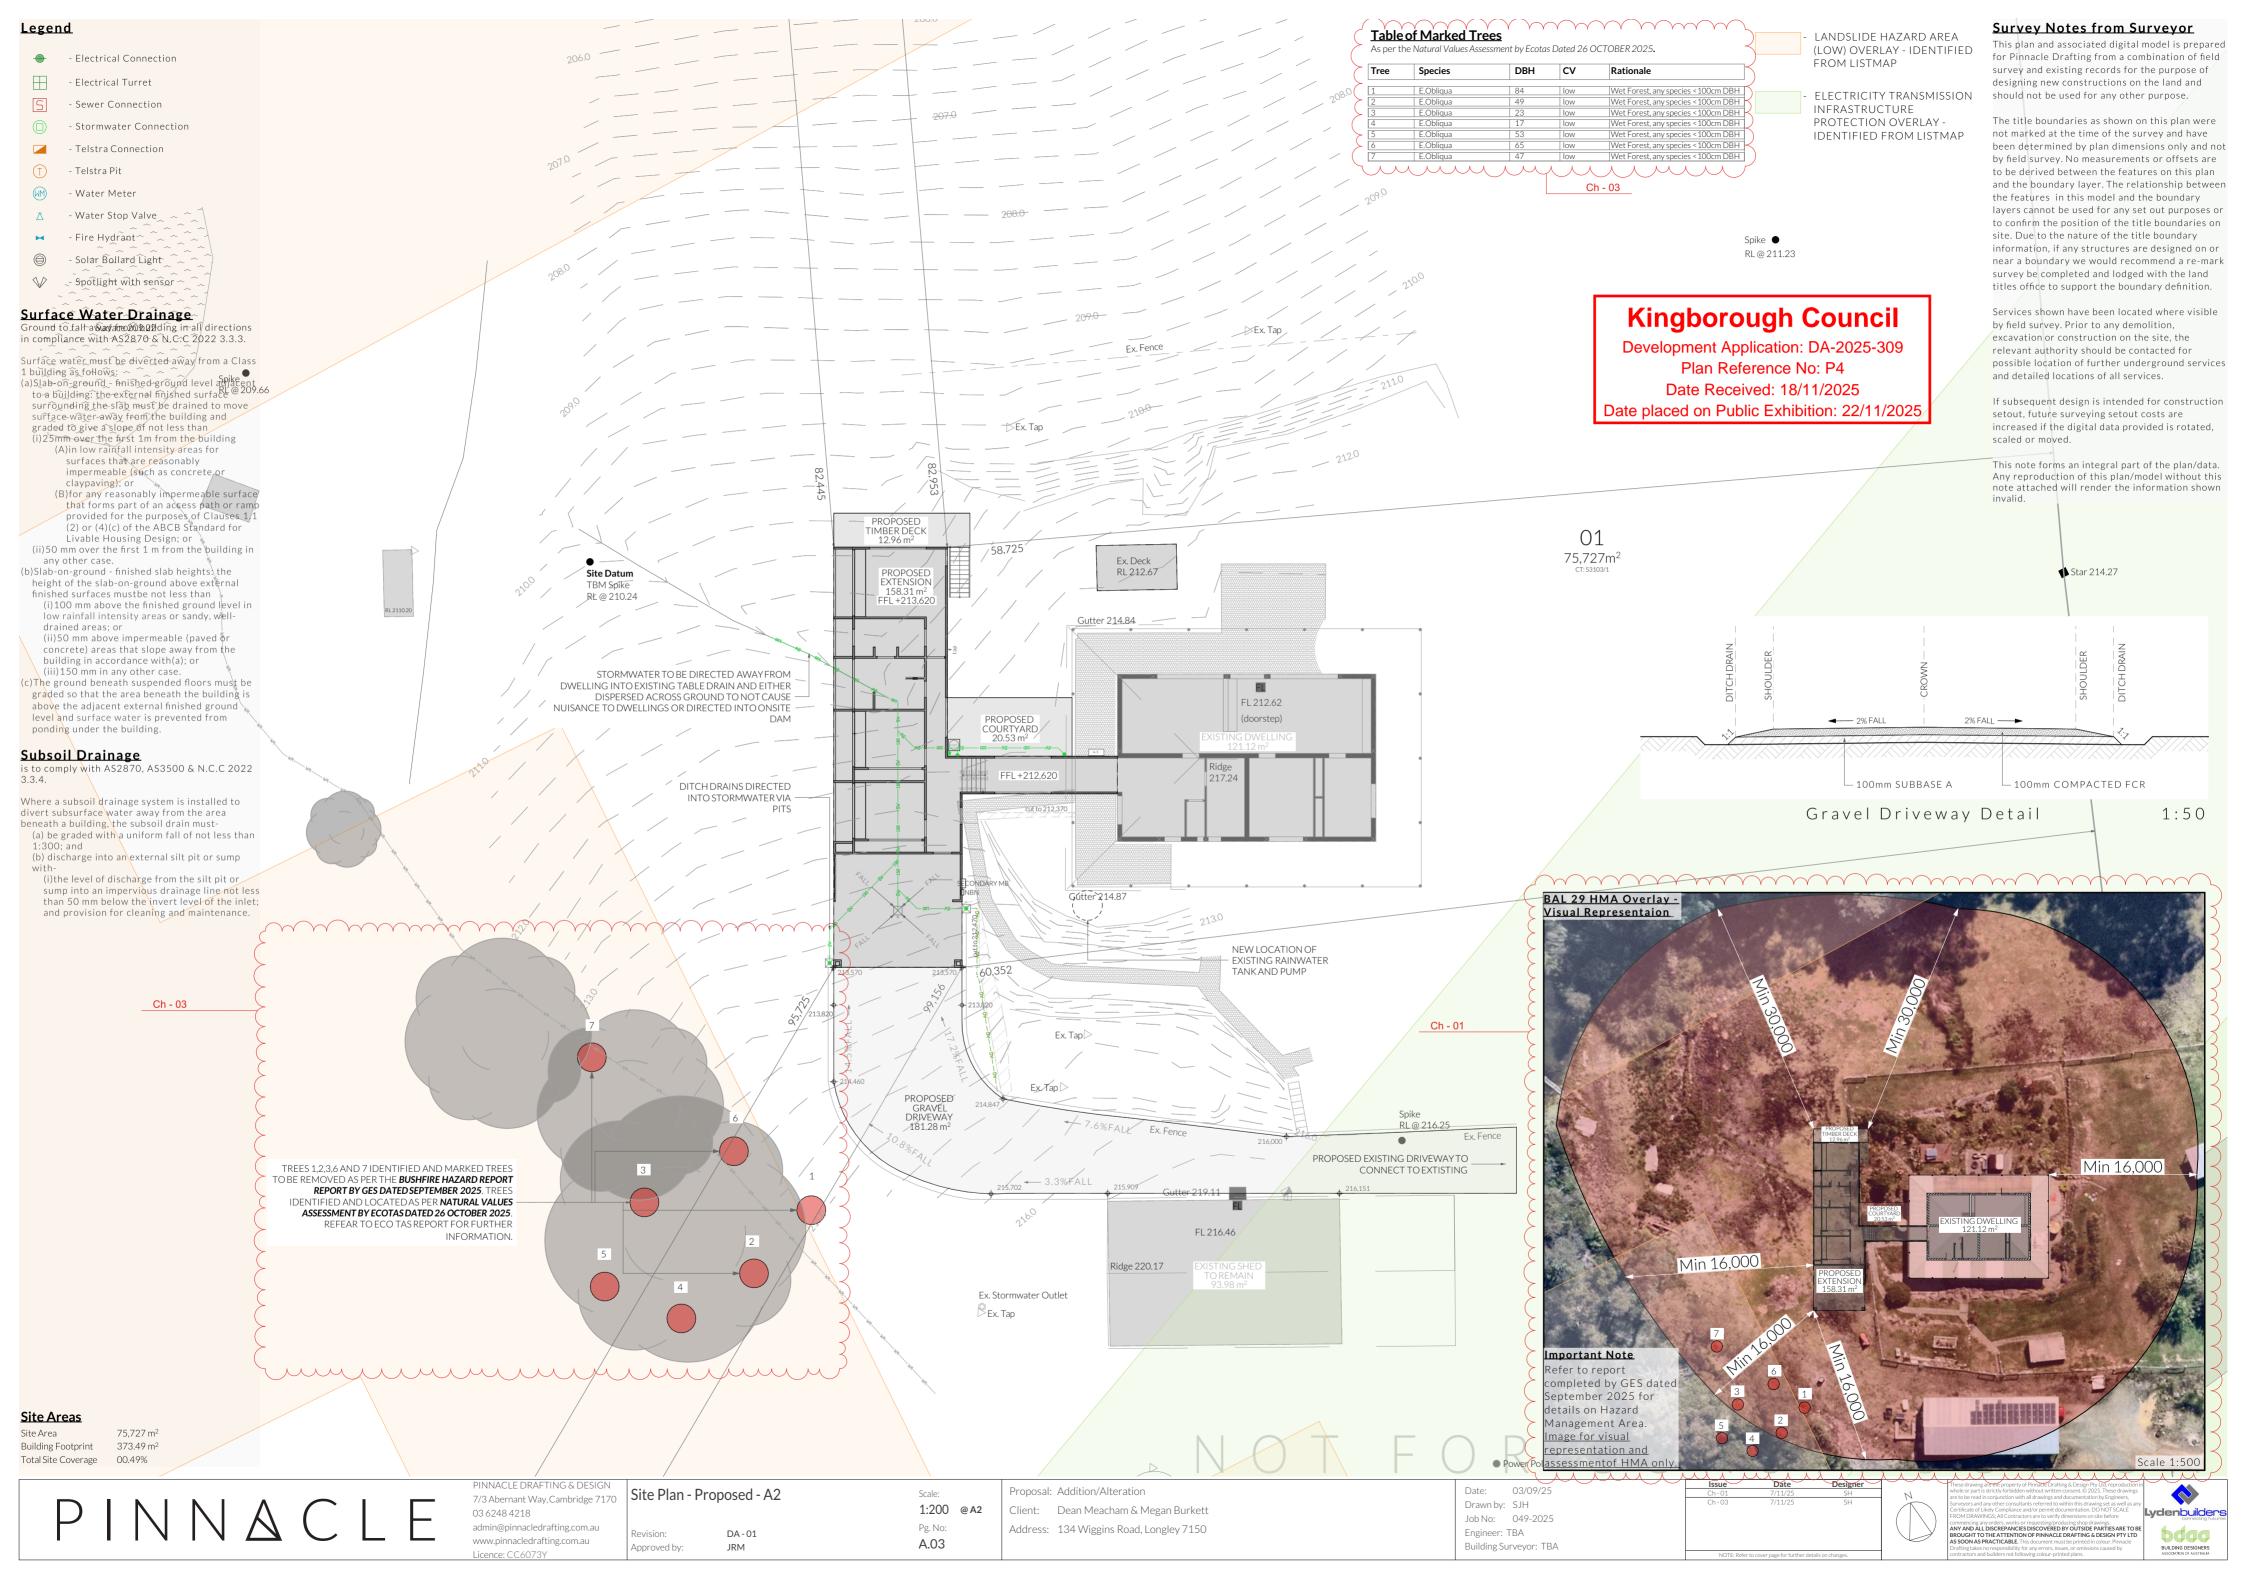

RENOVATION LEGEND

Construction of sanitary

compartments 10.4.2 of NCC 2022

The door to a fully enclosed sanitary compartment

open outwards; or

slide; or

be readily removable from the outside of the

unless there is a clear space of at least 1.2 m, measured in accordance with Figure 10.4.2 of NCC 2022 Vol II, between the closet pan within the sanitary compartment and the doorway.

Note: Safe Movement & Egress

Openable windows greater than 4m above the surface below are to be fitted with a device to limit opening or a suitable screen so a 125mm sphere cannot pass through. Except for Bedrooms, where the requirement is for heights above 2m. Refer to clauses 11.3.7 and 11.3.8 of NCC 2022 for further information on suitable protective devices.

Note: Paved Areas

All paths and patios to fall away from dwelling.

Note: Stair Construction

All stairs to be constructed in accordance with NCC Vol II 2022 Part 11.2.2: Riser: Min 115mm - Max 190mm Going: Min 240mm - Max 355mm Slope (2R+G): Max 550 - Min 700 For stairways serving non-habitable room used infrequently, refer to table 11.2.2(b).

Landings to comply with Clause 11.2.5 and be a minimum of 750mm deep measured 500mm from the inside edge of the landing.

Slip resistance of treads, nosings and ramps to comply with Clause 11.2.4.

Heights of rooms & other spaces


10.3.1 of NCC 2022

Heights of rooms and other spaces must not be less (a)in a habitable room excluding a kitchen - 2.4 m; and (b)in a kitchen - 2.1 m; and (c)in a corridor, passageway or the like - 2.1 m; and (d)in a bathroom, shower room, laundry, sanitary compartment, airlock, pantry, storeroom, garage, car parking area or the like - 2.1 m; and (e)in a room or space with a sloping ceiling or projections below the ceiling line within- See NCC directly for these items (f)in a stairway, ramp, landing, or the like - 2.0 m

measured vertically above the nosing line of stairway treads or the floor surface of a ramp, landing or the like. If required onsite, the builder may work within the

undertaking works.

tolerances of the above as specified within the NCC 2022 Vol II. Builder to contact Pinnacle before

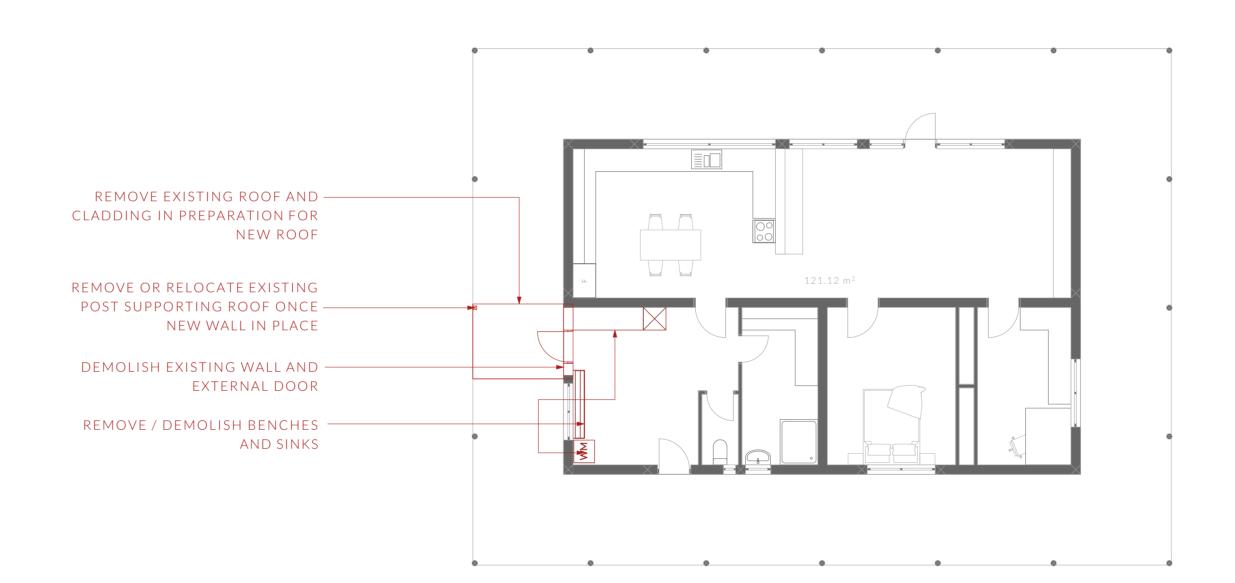

Kingborough Council

Development Application: DA-2025-309 Plan Reference No: P4 Date Received: 18/11/2025 Date placed on Public Exhibition: 22/11/2025

Floor Areas

Existing Floor Area 121.12m²



7/3 Abernant Way, Cambridge 7170 | Floor Plan - Demolition - A2 03 6248 4218 www.pinnacledrafting.com.au

DA - 01


JRM

Scale: 1:100 @ A2 Pg. No: A.04

Proposal: Addition/Alteration Client: Dean Meacham & Megan Burkett

Address: 134 Wiggins Road, Longley 7150

Date: 03/09/25 Drawn by: SJH Job No: 049-2025 Engineer: TBA Building Surveyor: TBA

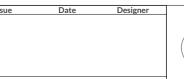





RENOVATION LEGEND

Smoke Alarm

Construction of sanitary

compartments 10.4.2 of NCC 2022 The door to a fully enclosed sanitary compartment

· open outwards; or

slide; or be readily removable from the outside of the compartment.

unless there is a clear space of at least 1.2 m, measured in accordance with Figure 10.4.2 of NCC 2022 Vol II. between the closet pan within the sanitary compartment and the doorway.

Note: Safe Movement & Egress

Openable windows greater than 4m above the surface below are to be fitted with a device to limit opening or a suitable screen so a 125mm sphere cannot pass through. Except for Bedrooms, where the requirement is for heights above 2m. Refer to clauses 11.3.7 and 11.3.8 of NCC 2022 for further information on suitable protective devices.

Note: Paved Areas

All paths and patios to fall away from dwelling.

Note: Stair Construction

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Landings to comply with Clause 11.2.5 and be a minimum of 750mm deep measured 500mm from the inside edge of the landing.

Slip resistance of treads, nosings and ramps to comply with Clause 11.2.4.


Heights of rooms & other spaces 10.3.1 of NCC 2022


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(a)in a habitable room excluding a kitchen - 2.4 m; and (b)in a kitchen - 2.1 m; and (c)in a corridor, passageway or the like - 2.1 m; and (d)in a bathroom, shower room, laundry, sanitary compartment, airlock, pantry, storeroom, garage, car parking area or the like - 2.1 m; and (e)in a room or space with a sloping ceiling or projections below the ceiling line within- See NCC directly for these items

(f)in a stairway, ramp, landing, or the like - 2.0 m measured vertically above the nosing line of stairway treads or the floor surface of a ramp, landing or the like.

If required onsite, the builder may work within the tolerances of the above as specified within the NCC 2022 Vol II. Builder to contact Pinnacle before undertaking works.



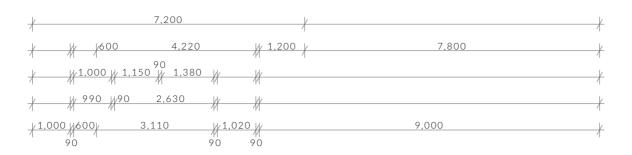

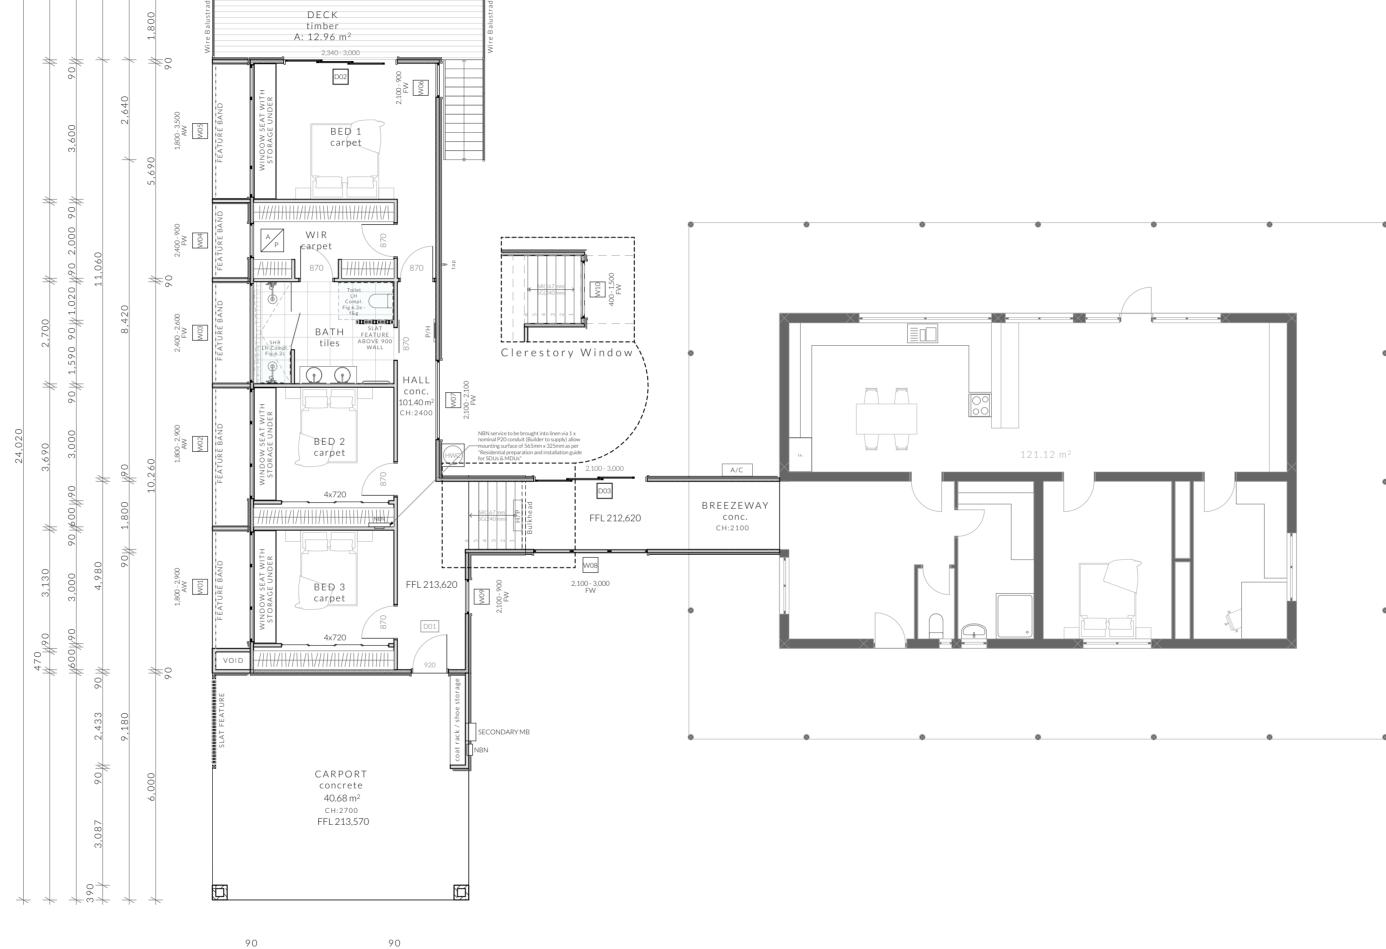1,890 / 1,225 / # 910 # 390 / 6,000 15,000

Kingborough Council

Development Application: DA-2025-309 Plan Reference No: P4 Date Received: 18/11/2025 Date placed on Public Exhibition: 22/11/2025

- BATTS TO WALL

Floor Areas

Existing Floor Area 121.12m² Proposed Floor Area 101.40m²
Carport 40.68m² Carport Total Floor Area 263.20m² 12.96m²

03/09/25 Proposal: Addition/Alteration Scale:

7/3 Abernant Way, Cambridge 7170 | Floor Plan - Proposed - A2 03 6248 4218 admin@pinnacledrafting.com.au www.pinnacledrafting.com.au


DA - 01

JRM

1:100 @ A2 Pg. No: A.05

Client: Dean Meacham & Megan Burkett Address: 134 Wiggins Road, Longley 7150

Drawn by: SJH Job No: 049-2025 Engineer: TBA Building Surveyor: TBA

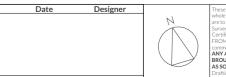








North Elevation - Existing

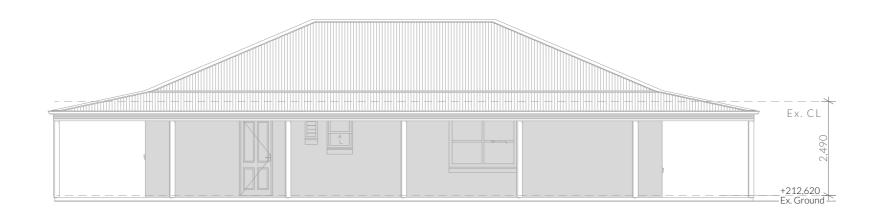

South Elevation - Existing

Kingborough Council

Development Application: DA-2025-309 Plan Reference No: P4

Date Received: 18/11/2025

Date placed on Public Exhibition: 22/11/2025

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Licence: CC6073Y

Elevations - Existing

Revision:

Approved by:

DA - 01

A.06

Scale: 1:100 @ A3 Pg. No:

Proposal: Addition/Alteration Client: Dean Meacham & Megan Burkett Address: 134 Wiggins Road, Longley 7150

Date: Drawn by: SJH Job No: 049-2025


Engineer: TBA Building Surveyor: TBA




RENOVATION LEGEND

- EXISTING

- DEMOLITION

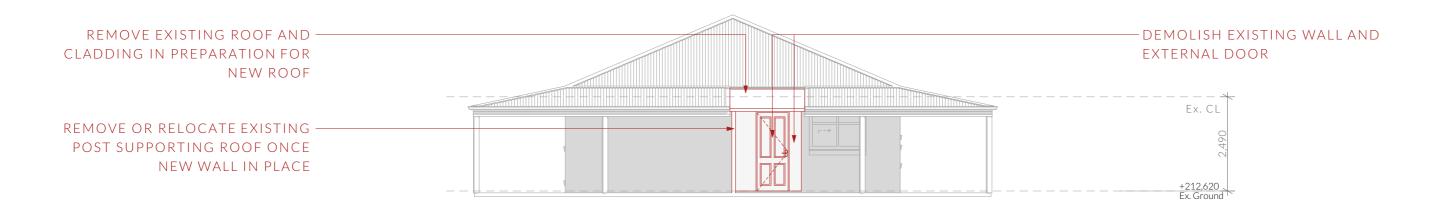

West Elevation - Demolition

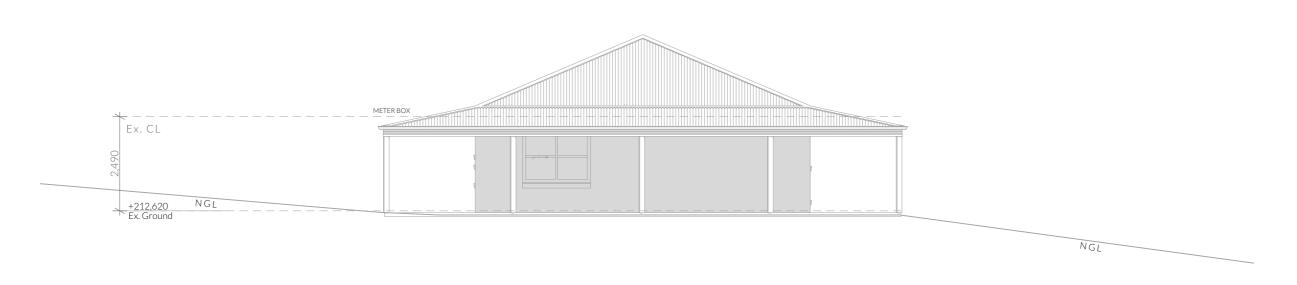

East Elevation - Existing

Kingborough Council

Development Application: DA-2025-309
Plan Reference No: P4

Date Received: 18/11/2025

Date placed on Public Exhibition: 22/11/2025

NOT FOR CONSTRUCTION

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Licence: CC6073Y

Elevations - Existing /
Demolition

Revision: DA-01

Approved by:

Scale: 1:100 @ A3 Pg. No: A.07 Proposal: Addition/Alteration

Client: Dean Meacham & Megan Burkett

Address: 134 Wiggins Road, Longley 7150

Date: 03/09/25 Drawn by: SJH Job No: 049-2025 Engineer: TBA

Building Surveyor: TBA


issue Date Designet

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- EXISTING - - NEW CONSTRUCTION NAILSTRIP 38, 265 PAN UNICOAT LUX 'TRIMDEK' SHEET METAL ROOF BEHIND PARAPET CLADDING INSTALLED TO PITCHED @ 29 MANUFACTURERS SPECIFICATIONS -CB MONUMENT CORTEN RED CONCRETE LANDING CL+213,620 0 Ground +212,620 NGL JAMES HARDIE SCYON AXON CLADDING, PAINT FINISH, INSTALLED WITH A VENTILATED CAVITY - CB MONUMENT STAIRS TO NGL WIRE BALUSTRADE TO COMPLY WITH NCC PART 11.3.6 & AS1288 AND BE NOT LESS THAN 1m ABOVE FFL OR 865mm SELECTED VENEERSTONE FINISH OVER FOR RAMPS AND NOSINGS. TOP RAIL TO BE PROVIDED. CORE FILLED CONCRETE BLOCK BUILDER MUST PROVIDE GLAZING INFORMATION TO BUILDING SURVEYOR PRIOR TO INSTALLATION

North Elevation - Proposed



South Elevation - Proposed

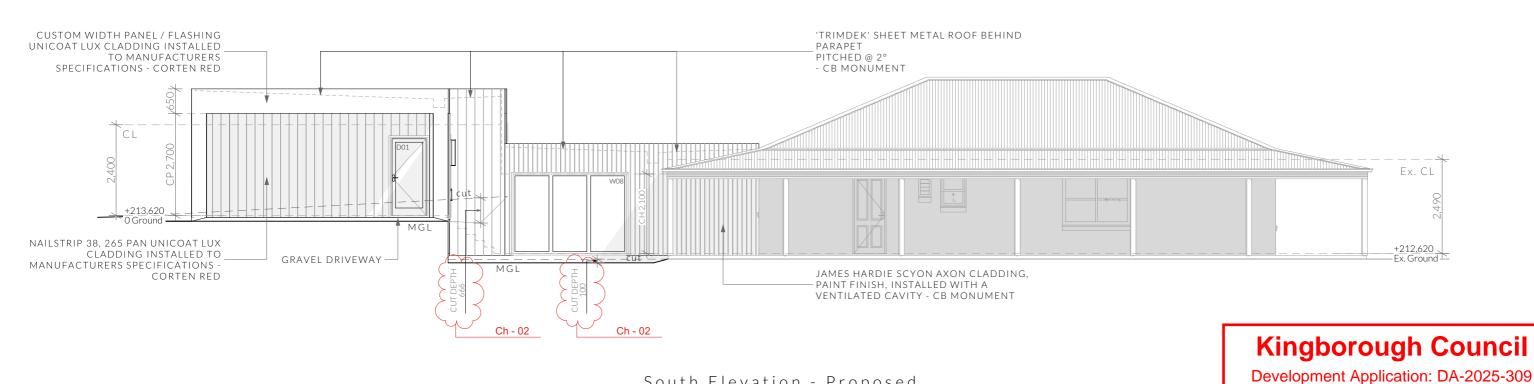NOTE Clearances between cladding and ground shall comply with Clause 7.5.7 of the NCC 2022 and shall be a minimum clearance of:

100mm in low rainfall intensity areas or sandy, well-drained areas; or 50mm above impermeable areas that slope away from the building; or 150mm in any other case.

Wall cladding must extend a minimum of 50 mm below the bearer or lowest horizontal part of the suspended floor framing.

U.N.O in builders specifications or located in saline environments or if using a glazed finish brick, brickwork is to be installed in stretcher bond pattern with raked joints.

Approved by:

Openable windows greater than 4m above ground level are to be fitted with a device to limit the opening or a suitable screen so a 125mm sphere cannot pass through, and withstand a force of 250N. Except for bedrooms, where the requirement is for heights

All stairs to be constructed in accordance with NCC 2022 Vol II Part 11.2.2

Riser: Min 115mm - Max 190mm Going: Min 240mm - Max 355mm

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Slope (2R+G): Max 550 - Min 700 Elevations - Proposed

DA - 01

1:100 @ A3 Pg. No: A.08

Scale:

Proposal: Addition/Alteration Client: Dean Meacham & Megan Burkett

Address: 134 Wiggins Road, Longley 7150


Date: Drawn by: SJH Job No: 049-2025

Engineer: TBA Building Surveyor: TBA


Plan Reference No: P4

Date Received: 18/11/2025



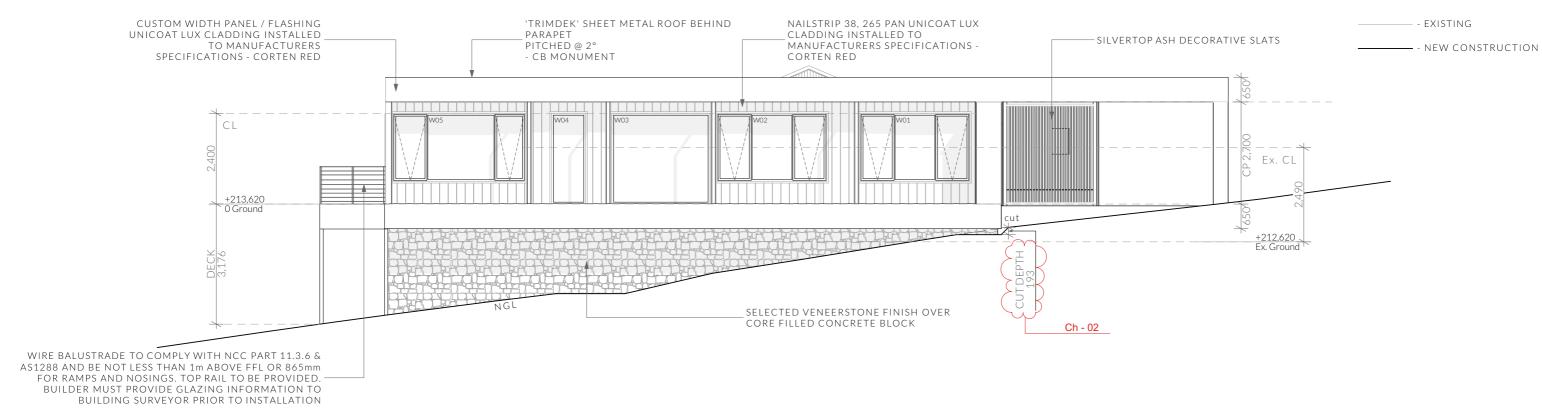

West Elevation - Proposed

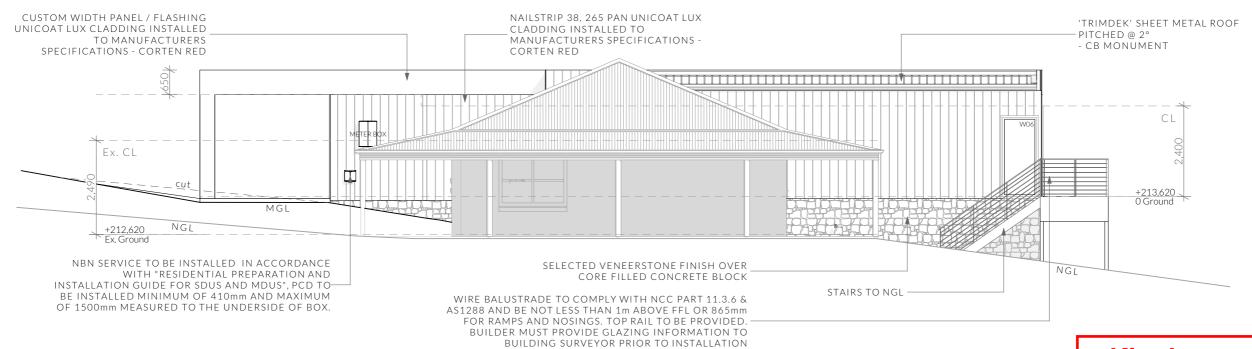

East Elevation - Proposed

NOTE

Clearances between cladding and ground shall comply with Clause 7.5.7 of the NCC 2022 and shall be a minimum clearance of:

100mm in low rainfall intensity areas or sandy, well-drained areas; or 50mm above impermeable areas that slope away from the building; or 150mm in any other case.

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All stairs to be constructed in accordance with NCC 2022 Vol II Part 11.2.2 Riser: Min 115mm - Max 190mm Going: Min 240mm - Max 355mm

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Licence: CC6073Y

Approved by:

Slope (2R+G): Max 550 - Min 700 Elevations - Proposed

Pg. No: DA - 01 A.09

Scale: Proposal: Addition/Alteration 1:100 @ A3

Client: Dean Meacham & Megan Burkett Address: 134 Wiggins Road, Longley 7150

Date: Drawn by: SJH Job No: 049-2025 Engineer: TBA Building Surveyor: TBA

ydenbuilders ANY AND ALL DISCREPANCIES DISCOVERED BY OUTSIDE PARTIES ARE BROUGHT TO THE ATTENTION OF PINNACLE DRAFTING & DESIGN PTY AS SOON AS PRACTICABLE. This document must be printed in colour. Pinnacle

Kingborough Council

Development Application: DA-2025-309

Plan Reference No: P4

Date Received: 18/11/2025

Ventilation of roof spaces NCC 2022 Part 10.8.3

A roof must have a roof space that-

(a)is located-

(i)immediately above the primary insulation layer;

(ii)immediately above sarking with a vapour permeance of not less than 1.14 µg/N.s, which is immediately above the primary insulation layer;

(iii)immediately above ceiling insulation; and (b) has a height of not less than 20 mm; and (c)is either-

(i)ventilated to outdoor air through evenly distributed openings in accordance with Table

(ii)located immediately underneath the roof tiles of an unsarked tiled roof.

Stormwater Notes

All gutters, downpipes and rain heads to be designed and installed in compliance with AS3500.3 & NCC 2022 Volume II Part 7.4.

Roofing Cladding

Roof cladding, flashings, cappings, roof sheeting and fixings are to be installed in accordance with NCC 2022 Volume II Part 7.2 for sheet roofing and Part 7.3 for tiled and shingle roofing.

Eaves & Soffit Linings

To comply with NCC 2022 Vol II Part 7.5.5 and where provided, external fibre-cement sheets and linings used as eaves and soffit linings must-

(a)comply with AS/NZS 2908.2 or ISO 8336; and (b)be fixed in accordance with Table 7.5.5 and Figure 7.5.5 using-

(i) 2.8×30 mm fibre-cement nails; or

(ii) No. 8 wafer head screws (for 4.5 mm and 6 mm sheets only); or

(iii) No. 8 self embedding head screws (for 6 mm

Refer to table 7.5.5 for trimmer and fastener spacings.

Parapet cappings

Where a wall cladding is used to form a parapet wall, the cladding must be attached to a supporting frame and have a capping installed that complies with the following: (a) Cappings must-

(i)be purpose made, machine-folded sheet metal or equivalent sections of a material compatible with all up and downstream metal roof covering materials in accordance with 7.2.2(2): and

(ii) extend not less than 50 mm down the sides of the parapet;

(iii)be separated from the supporting framing by a vapour permeable sarking installed in accordance with (f); and (iv)be fixed with either self drilling screws or rivets with rubber washers at intervals of not more than 500 mm that do not penetrate the top of cappings, except at joints and corners.

(b) The top of the capping must slope a minimum of 5 degrees. (c) Joints in cappings must-

(i)overlap by not less than 50 mm in the direction of flow; and (ii) be securely fastened at intervals of not more than 40 mm;

(iii)have sealant installed between laps

(d) Fixing for cappings must be compatible with the capping material in accordance with 7.2.2.

(e)Lead cappings must not be used with prepainted steel or zinc/aluminium steel or on any roof if the roof is part of a drinking water catchment area.

(f)Sarking must comply with AS 4200.1 and be installed behind all wall cladding where parapets are installed, with-

(i)each adjoining sheet or roll being-(A)overlapped not less than 150 mm; or

(B)taped together; and

sarking fixed to supporting members at not more than 300 mm centres.

VENTILATION OF OPENINGS (TABLE 10.8.3) ROOF PITCH < 100 25,000 mm2/m provided at each of two opposing ends

(1) Ventilation openings are specified as a minimum free open area per metre length of the longest horizontal dimension of the roof.

(2) For the purposes of this Table, high level openings are openings provided at the ridge or not more than 900 mm below the ridge or highest point of the roof space, measured vertically.

PARAPET WALL

ROOF PITCH < 10° PARAPET ROOF - LIGHTWEIGHT CLAD

REQUIRED NUMBER OF ROOF VENTS:

REQUIRED VENT AREA

Low Vents = $0.55m^2 (22.22m \times 25,000mm^2)$ High Vents = 0.55m² (22.22m x 25,000mm²)

24x HARON 300x150 WALL VENTS (0.023m2)

25mm CONTINUOUS VENT

HIGH VENTS

SHEET METAL FASCIA & FLASHINGS

SHEET METAL 'TRIMDEK' ROOF PITCHED


@ 2° OVER TRUSSES WITH 70x35 MGP12

24x HARON 300x150 WALL VENTS (0.023m²)

25mm CONTINUOUS VENT UNER FEATURE BAND

NOTE: VENTS BASED ON USE OF 300x150 WALL VENT FITTED WITH STAINLESS STEEL ANTI SPARK BUSHFIRE OVERFLOW WEIR 25 I - EXTERNAL WALI 90ø DOWNPIPE

EXTERNAL RAIN HEAD DETAIL (TYP) N.T.S

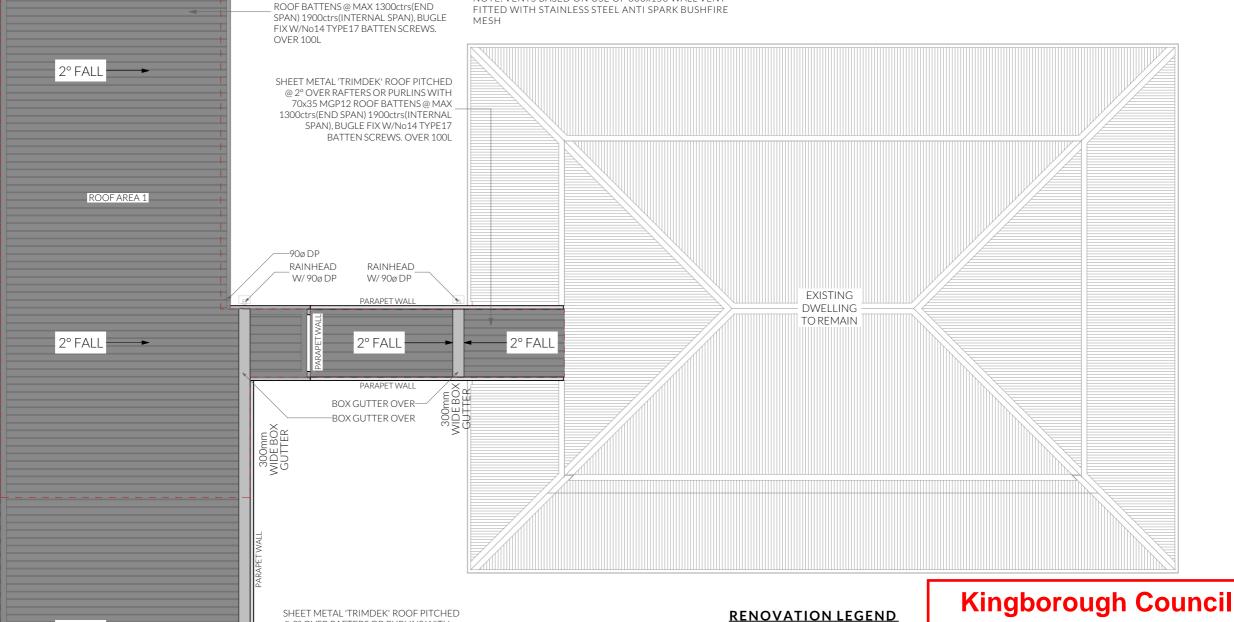

PINNACLE

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Roof Plan

Revision:

Approved by:

PARAPET WALL

2° FALL

DA - 01

Scale: 1:100 @ A3 Pg. No:

A.10

Proposal: Addition/Alteration Client: Dean Meacham & Megan Burkett

@ 2° OVER RAFTERS OR PURI INS WITH

1300ctrs(END SPAN) 1900ctrs(INTERNAL

70x35 MGP12 ROOF BATTENS @ MAX

SPAN) BUGI F FIX W/No14 TYPF17

BATTEN SCREWS, OVER 100L

Address: 134 Wiggins Road, Longley 7150

Date: Drawn by: SJH

Job No: 049-2025 Engineer: TBA Building Surveyor: TBA



- EXISTING

- NEW CONSTRUCTION

Development Application: DA-2025-309

Plan Reference No: P4

Date Received: 18/11/2025





ELECTRICAL LEGEND - Lower Floor

ELECTRICA LE LEGEND LOWER FROM					
Symbol	Description	Allowance	Quantity		
∇□	DATA-CAT 6 (RJ45) - 1 GANG		1		
	FAN - 3 IN 1 (4 LAMP)	10W (LIGHT)	1		
0	FAN - CEILING - EXHAUST		1		
2	GPO - (2) DOUBLE		11		
P/HEAT	GPO - PERMANENT CONNECTION (PANEL HEATER)		1		
2	GPO - WEATHER PROOF DOUBLE		3		
⊗ _R	LIGHT - CEILING - DOWNLIGHT RECESSED	10W	20		
	LIGHT - CEILING - LED BATTEN	20W	4		
\bigotimes_{W1}	LIGHT - WALL MOUNTED - TYPE 1	10W	2		
$\overline{\otimes}_{W2}$	LIGHT - WALL MOUNTED - TYPE 2	10W	5		
(SA)	SERVICE - SMOKE ALARM		2		
Ь	SWITCH - LIGHT 1 GANG		7		
2₫	SWITCH - LIGHT 2 GANG		3		
зЬ	SWITCH - LIGHT 3 GANG		2		
Φ	SWITCH-WITH TIMER		2		

Note: Exhaust Fans

Exhaust fans to comply with NCC 2022 Vol 2 Part 10.8.2 and

- -An exhaust system installed in a kitchen, bathroom, sanitary compartment or laundry must have a minimum flow rate of-(a)25 L/s for a bathroom or sanitary compartment; and (b)40 L/s for a kitchen or laundry.
- -Exhaust from a kitchen, kitchen range hood, bathroom, sanitary compartment or laundry must discharge directly or via a shaft or duct to outdoor air.
- -Where a venting clothes dryer is installed, it must discharge directly or via a shaft or duct to outdoor air.
- -An exhaust system that is not run continuously and is serving a bathroom or sanitary compartment that is not ventilated in accordance with 10.6.2(a) must-
- (a) be interlocked with the room's light switch; and (b)include a run-on timer so that the exhaust system continues to operate for 10 minutes after the light switch is turned off.

Smoke Alarms Part 9.5 of NCC 2022

Smoke alarms must-

(a)be located in-

(i)a Class 1a building in accordance with 9.5.2 and 9.5.4; and (ii)a Class 1b building in accordance with 9.5.3 and 9.5.4;

(b)comply with AS 3786, except that in a Class 10a private garage where the use of the area is likely to result in smoke alarms causing spurious signals, any other alarm deemed suitable in accordance with AS 1670.1 may be installed provided that smoke alarms complying with AS 3786 are installed elsewhere in the Class 1 building; and

(c)be powered from the consumer mains source where a consumer mains source is supplied to the building; and be interconnected where there is more than one alarm

In a Class 1a building, smoke alarms must be located in-(a) any storey containing bedrooms, every corridor or hallway associated with a bedroom, or if there is no corridor or hallway, in an area between the bedrooms and the remainder of the building; and

(b) each other storey not containing bedrooms.

Smoke alarms required by 9.5.2 and 9.5.3 must be installed on or near the ceiling, in accordance with the following:

(a) Where a smoke alarm is located on the ceiling it must be-(i)a minimum of 300 mm away from the corner junction of the wall and ceiling; and

(ii)between 500 mm and 1500 mm away from the high point and apexes of the ceiling, if the room has a sloping ceiling. (b)Where (a) is not possible, the smoke alarm may be installed

on the wall, and located a minimum of 300 mm and a maximum of 500 mm off the ceiling at the junction with the

Note: Lighting

Lighting layout may change, owner to confirm with builder prior to purchase/installation of exact quantity and location of electrical services provided that installation is compliant with AS3000 and artificial lighting allowances do not exceed:

5W/m² in class 1a dwellings

4W/m² to veranda, balcony or the like

3W/m² in a class 10a dwelling associated with the class 1a

U.N.O - All downlights are to be Insulation Contact (IC) rated.

Preparation for future Solar Installation:

Should the solar design be required for future installation, 2/25mm solarflex (or similar) conduits marked "solar" are to be installed from the meter box to the roof space.

<u>Notes</u>

U.N.O ceilings are to be plasterboard.


--□---- Dimmable Circuit

-- T---- Timer Circuit(as fan note)

- Plasterboard

CS - Cement Sheet Eaves

- Plywood Ceiling

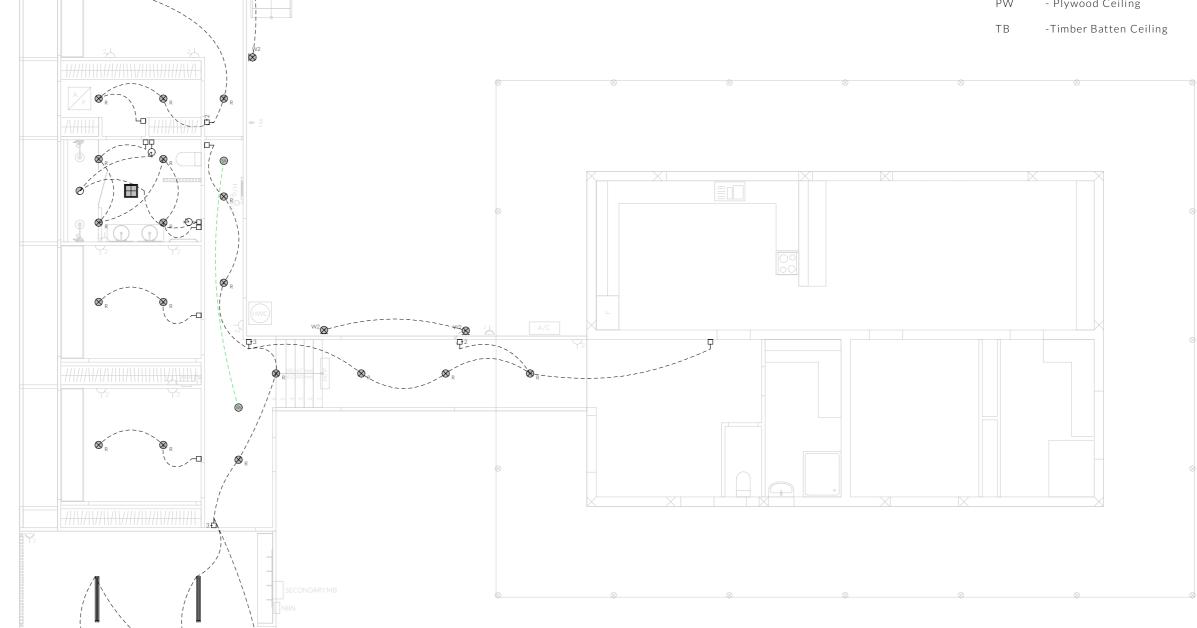

Kingborough Council

Development Application: DA-2025-309 Plan Reference No: P4

Date Received: 18/11/2025 Date placed on Public Exhibition: 22/11/2025

PINNACLE

PINNACLE DRAFTING & DESIGN 7/3 Abernant Way, Cambridge 7170 03 6248 4218 admin@pinnacledrafting.com.au

www.pinnacledrafting.com.au

Licence: CC6073Y

Electrical Plan - Reflected Ceiling

DA - 01 Approved by:

Scale: Pg. No:

A.11

Proposal: Addition/Alteration

Client: Dean Meacham & Megan Burkett Address: 134 Wiggins Road, Longley 7150

Drawn by: SJH Job No: 049-2025

Engineer: TBA Building Surveyor: TBA





FLECTRICAL LEGEND - Lower Floor

ELECTRICAL LEGEND - LOWER FROM					
Symbol	Description	Allowance	Quantity		
∇□	DATA- CAT 6 (RJ45) - 1 GANG		1		
	FAN - 3 IN 1 (4 LAMP)	10W (LIGHT)	1		
0	FAN - CEILING - EXHAUST		1		
2	GPO - (2) DOUBLE		11		
P/HEAT	GPO - PERMANENT CONNECTION (PANEL HEATER)		1		
2	GPO - WEATHER PROOF DOUBLE		3		
$\otimes_{_{R}}$	LIGHT - CEILING - DOWNLIGHT RECESSED	10W	20		
	LIGHT - CEILING - LED BATTEN	20W	4		
$\overline{\otimes}_{W1}$	LIGHT - WALL MOUNTED - TYPE 1	10W	2		
$\overline{\otimes}_{W2}$	LIGHT - WALL MOUNTED - TYPE 2	10W	5		
(SA)	SERVICE - SMOKE ALARM		2		
Ь	SWITCH - LIGHT 1 GANG		7		
2₫	SWITCH - LIGHT 2 GANG		3		
3₫	SWITCH - LIGHT 3 GANG		2		
ф	SWITCH - WITH TIMER		2		

Note: Exhaust Fans

Exhaust fans to comply with NCC 2022 Vol 2 Part 10.8.2 and

- -An exhaust system installed in a kitchen, bathroom, sanitary compartment or laundry must have a minimum flow rate of-(a)25 L/s for a bathroom or sanitary compartment; and (b)40 L/s for a kitchen or laundry.
- -Exhaust from a kitchen, kitchen range hood, bathroom, sanitary compartment or laundry must discharge directly or via a shaft or duct to outdoor air.
- -Where a venting clothes dryer is installed, it must discharge directly or via a shaft or duct to outdoor air.
- -An exhaust system that is not run continuously and is serving a bathroom or sanitary compartment that is not ventilated in accordance with 10.6.2(a) must-
 - (a) be interlocked with the room's light switch; and (b)include a run-on timer so that the exhaust system continues to operate for 10 minutes after the light switch is turned off.

Smoke Alarms Part 9.5 of NCC 2022

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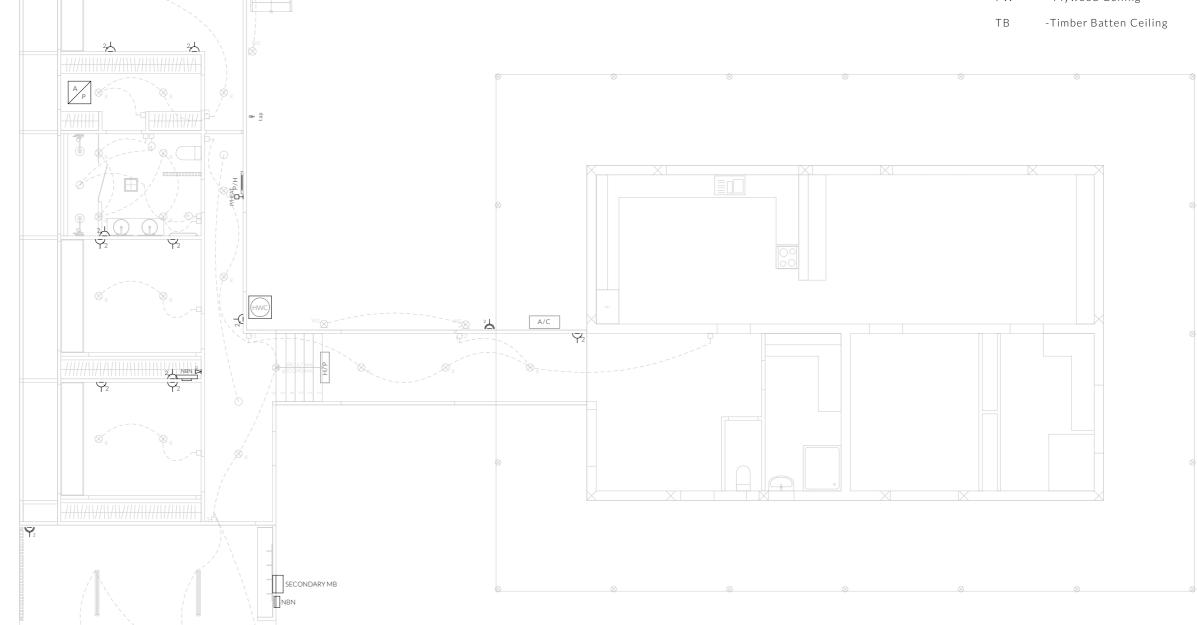
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Licence: CC6073Y

Electrical Plan - Power

Approved by:

DA - 01

Scale:

Pg. No:

A.12

Proposal: Addition/Alteration

Client: Dean Meacham & Megan Burkett

Drawn by: SJH Job No: 049-2025 Address: 134 Wiggins Road, Longley 7150 Engineer: TBA

Date:

Building Surveyor: TBA





